


LEGEND **ROAD NAME**

_ . __ . __ . _

— X —— X —

———— UGE——



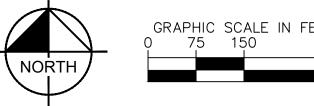

W CURTIS ROAD

*ZONING SITE PLAN IS BEING SUBMITTED FOR SPECIAL USE PERMIT TO CONSTRUCT/OPERATE A COMMERCIAL SOLAR ENERGY SYSTEM

SOILS DATA TABLE

MAP UNIT NAME

DANA SILT LOAM, 2 TO 5 PERCENT SLOPES

BRENTON SILT LOAM, 0 TO 2 PERCENT SLOPES

DRUMMER SILTY CLAY LOAM, 0 TO 2 PERCENT SLOPES FLANAGAN SILT LOAM, 0 TO 2 PERCENT SLOPES

CATLIN SILT LOAM, 2 TO 5 PERCENT SLOPES

ELBURN SILT LOAM, 0 TO 2 PERCENT SLOPES

THORP SILT LOAM, 0 TO 2 PERCENT SLOPES

PEOTONE SILTY CLAY LOAM, 0 TO 2 PERCENT SLOPES

WYANET SILT LOAM, 5 TO 10 PERCENT SLOPES, ERODED

BLACKBERRY SILT LOAM, 2 TO 5 PERCENT SLOPES

W WINDSOR ROAD 🔤

- PROJECT LOCATION

HYDROLOGIC SOIL GROUP

B/D

B/D

C/D

С

B/D

C/D

C/D





 Z_{i} O Ш

Σ 60

0

0 - 0 0 0 0 0	DATE 7/30/25	AS SHOWN	LLR	LLR	\(\text{\tin}\text{\tett{\text{\text{\text{\text{\text{\text{\text{\text{\text{\text{\ti}\text{\text{\text{\text{\text{\text{\text{\text{\text{\texi}\tint{\text{\text{\text{\ti}}\text{\text{\text{\text{\text{\text{\texitt{\text{\text{\text{\text{\text{\texi}\text{\text{\text{\text{\text{\text{\text{\texi}\text{\text{\texi}\text{\text{\texit}\titt{\text{\texi}\text{\text{\text{\text{\text{\text{\tet
0 0 0	D4 7/30	E AS	NED BY	≻ B Z	VEN BY

Z

SHEET NUMBER

	ONLINE.
	STORMWATER MANAGEMENT FACILITIES TO BE PROVIDED AS REQUIRED BY COUNTY AND/OR NATIONAL POLLUTANT DISCHARGE ELIMINATION SYSTEM (NPDES) PERMITTING. REQUIREMENTS TO BE DETERMINED DURING FINAL ENGINEERING.
3.	THE MAXIMUM HEIGHTS OF ANY SOLAR PANEL SHALL NOT EXCEED 20 FEET AT FULL TILT.
	COLAD DANIELO WILL DE DECICIED MITH ANTI DEFLECTIVE COLATIVO TO LIMINATE CLADE

- 14. SOLAR PANELS WILL BE DESIGNED WITH ANTI—REFLECTIVE COATING TO MINIMIZE GLARE.
- 15. THERE SHALL BE NO EXTERIOR LIGHTING.
- 16. SETBACKS SHOWN ON THIS PLAN ARE BASED ON 55 ILCS 5/5-12020 AND CHAMPAIGN COUNTY ORDINANCE SECTION 6.1.5.
- 17. ALL NECESSARY PERMITS FOR SOIL EROSION CONTROL AND DRIVEWAY CONSTRUCTION WILL BE OBTAINED AS PART OF FINAL ENGINEERING AND PRIOR TO CONSTRUCTION.
- PROPOSED UTILITY POLE LOCATIONS, LAYOUT, UNDERGROUND, AND OVERHEAD ELECTRIC LINES SUBJECT TO CHANGE BASED ON FINAL ENGINEERING AND COORDINATION WITH AMEREN.
- 19. ABOVE GROUND DC CABLE MANAGEMENT SYSTEM IS TO BE EMPLOYED WITHIN THE ARRAY BOUNDARIES.


EX. RESIDENCE/STRUCTURE RESIDENCE/STRUCTURE SETBACK (PER ILCS) SCALE 1" = 3000' EX. FLOOD ZONE A (PER ALTA) SITE DATA TABLE PROPERTY OWNER FOERSTERLING FARM LLC EX. OVERHEAD WIRE (TRACED PER AERIAL) ____ EX OHE ____ ALONG W WINDSOR ROAD (BETWEEN S BARKER ROAD AND S RISING ROAD). SITE ADDRESS CHAMPAIGN, IL 61822 EX. UTILITY POLE (TRACED PER AERIAL) ZONING JURISDICTION CHAMPAIGN COUNTY ZONING DISTRICT 8100 - AGRICULTURE* EX. GAS LINE (PER ALTA) AGRICULTURAL CURRENT LAND USE PROPOSED USE COMMERCIAL SOLAR ENERGY FACILITY EX. MID-AMERICA PIPLINE EASEMENT (PER ALTA) ______ TOTAL PARCEL AREA $202.59 \pm AC$ EX. SOIL BOUNDARIES (PER NRCS) PRELIMINARY DISTURBED AREA $16.82 \pm AC$ (AREA WITHIN FENCE) 12.91 ± AC PRELIMINARY SOLAR AREA ROAD RIGHT-OF-WAY 50' SETBACK EX. HIGH TENSION WIRE (PER ALTA) PROPERTY LINE SETBACK 50' 150' RESIDENTIAL LINE SETBACK EX. GRAVEL DRIVEWAY (PER ALTA) TOTAL POWER OUTPUT (DC) 4.49 MW TOTAL POWER OUTPUT (AC) 3.00 MW EX. COMMUNICATION STRUCTURE (PER ALTA) DC/AC RATIO 1.50 EX. STORM STRUCTURE (PER ALTA) 37.35% GROUND COVER RATIO (GCR) 7,550 TOTAL NUMBER OF MODULES EX. STORM PIPE (PER ALTA)

MAP UNIT SYMBOL

198A

622C2

NOTES

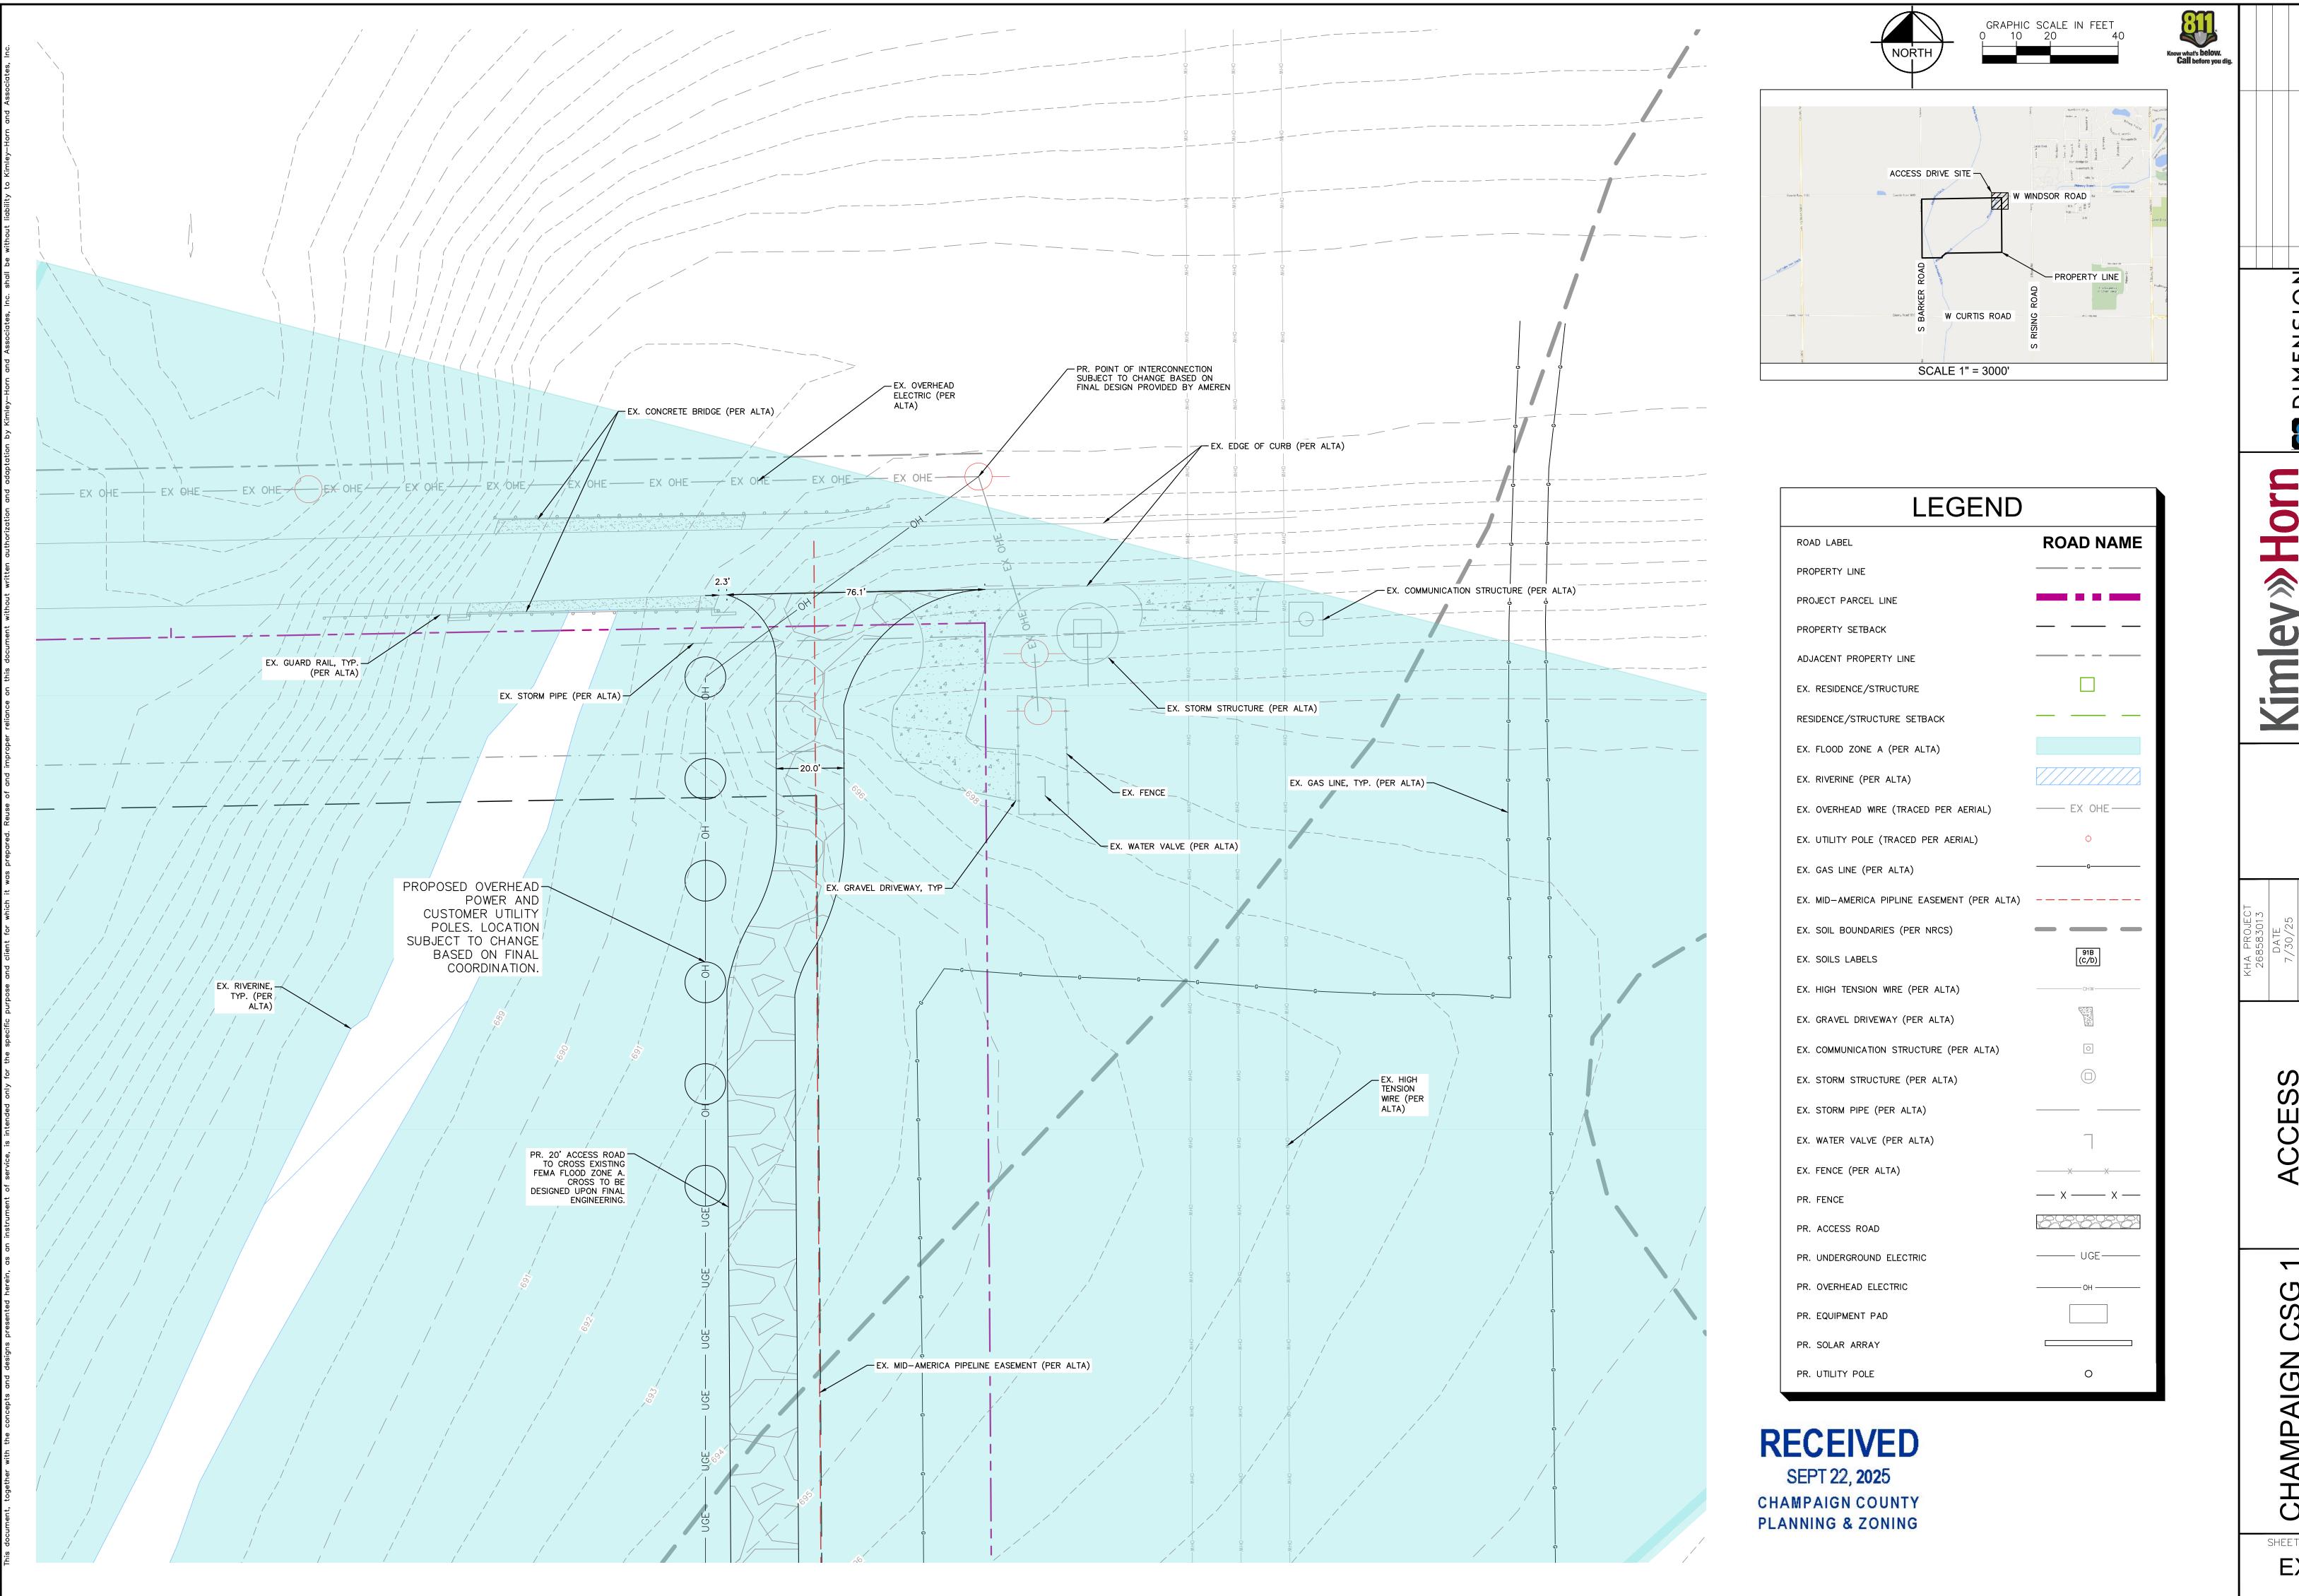

DIMENSION RENEWABLE ENERGY

SENEWABL

Y-HORN AND ASSOCIATES, INC.
E COOK ROAD, SUITE 200
EERFIELD, IL 60015
NNE: (630) 487-3449

© 2025 KIMLEY-H 570 LAKE CC DEERF PHONE:


7/30/25
SCALE AS SHOWN
DESIGNED BY LLR
DRAWN BY LLR

ACCESS DRIVE

HAMPAIGN CSG 1
LLC

SHEET NUMBER **EX-1**

Case 175-S-25; 1:40

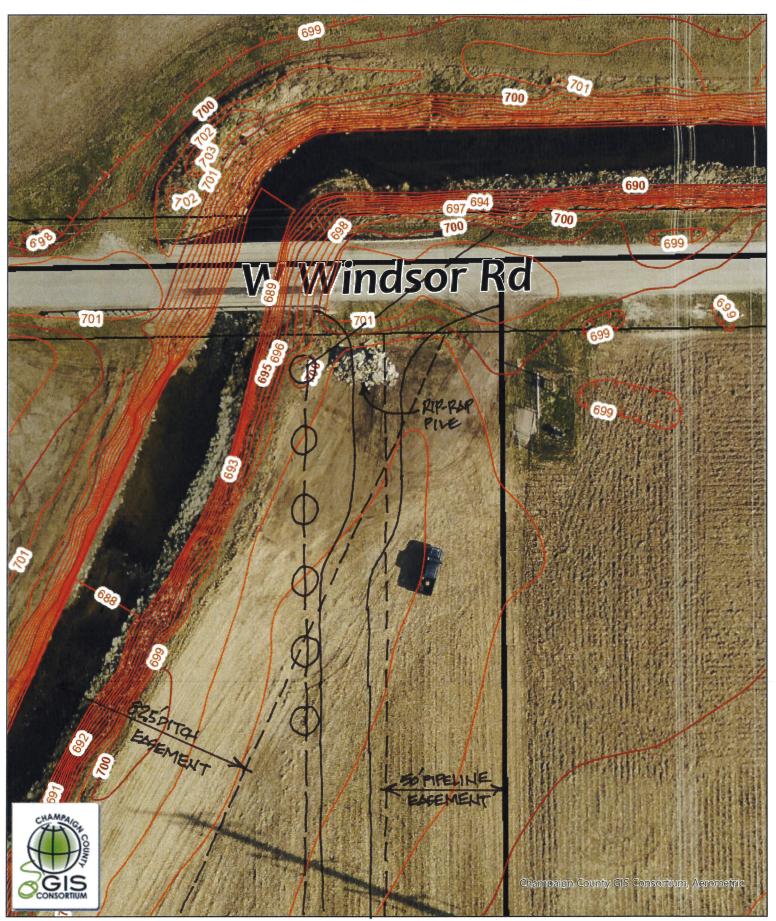

This map application was prepared with geographic information system (GIS) data created by the Champaign County GIS Consortium (CCGISC), or other CCGISC member agency. These entities do not warrant or guarantee the accuracy or suitability of GIS data for any purpose. The GIS data within this application is intended to be used as a general index to spatial information and not intended for detailed, site-specific analysis or resolution of legal matters. Users assume all risk arising mi from the use or misuse of this application and information contained herein. The use of this application constitutes acknowledgement of this disclaimer.



Charles W. Campo

From: Don Wauthier <dwauthier@bernsclancy.com>
Sent: Thursday, September 25, 2025 12:26 PM

To: Charles W. Campo

Subject: Case 175-S-25 CSG 1 Community Solar Energy Project

CAUTION: External email, be careful when opening.

Mr Campo and members of the Champaign County Zoning Board of Appeals,

I offer the following comments about this proposed Special Use as a concerned citizen of Champaign County:

- I am in favor of solar energy projects. Properly installed I believe that they will be beneficial to society as a whole
- This applicant submits as Exhibit O the scientific study "Hydrologic Response of Solar Farms" written by Cook & McCuen published May 2013. That study is now 12+ years old and consisted of a desk top theoretical analysis of drainage conditions within a theoretical solar energy project sie. While Solar Project applicants often cite it as a basis for determining that solar projects do not alter drainage conditions, that assumption is incorrect. The study used several assumptions that no longer apply to most solar energy projects. Further during the subsequent 12 years additional scientific investigation has revealed that the conclusions drawn in that study are often inaccurate. Thus that study is no longer considered relevant by the larger scientific community. Champaign County should **NOT** utilize the results of that study as a basis for review of this project. A separate site specific drainage analysis should be prepared.
- The vegetation maintenance plan indicates that native and pollinator plants are to be grown. The soils at this site are effectively some of the best, most productive soils in the entire world. Please consider requiring the applicant to implement agrivoltaics at this site. There are a great many dual use agricultural uses that can be implemented within a solar energy site. Please require continued joint agricultural use of the site. To do so is a win/win for everyone.
- Fountain Head Drainage District operates the adjacent Copper Slough channel. While I do not represent them it is likely that the drainage district has information about tile lines within this site.

I appreciate this opportunity to provide input into the Special Use approval process. Thank you for considering my input.

Sincerely,

Don Wauthier 1831 Tahoe Court Champaign Illinois

Phone: (217) 493-7799

Email: dwauthier@bernsclancy.com

This communication is covered by the Electronic Communications Privacy Act and is intended to remain confidential. If you are not the intended recipient of this message or if this message has been sent to you in error please immediately alert the sender and delete this message and all attachments. If you are not the intended recipient do not deliver, distribute, copy, disclose the contents, or in any way rely upon the message or its contents.

To the members of the Zoning Appeals Board,

Thank you for your service to the citizens of our County, and for carefully considering the Special Use permits that come before you.

We, the undersigned residents, support the building of new Community Solar projects in Champaign County. We are current users or hope to become users of Community Solar. Community Solar enables residents to benefit directly from solar projects. It lets us use clean, low cost solar, even if our homes are not good sites for solar panels. (Both homeowners and renters can participate in Community Solar.)

The benefit is a guaranteed 10-20% savings on electricity supply charges. A recent national survey found that Ameren ratepayers experienced the third largest price increases in the nation: \$540/year. As prices in our market have risen sharply, the Community Solar projects help consumers achieve significant savings which helps our family budgets. Around five hundred households can benefit from a 3MW project like the one before you tonight.

Community Solar is available to any Ameren customer, and demand for it has outpaced supply in our area. This means there are waiting lists to participate in some projects, and having more projects would mean that more of your constituents and our neighbors could sign up and save.

We hope that you will recommend Dimension's Foersterling Farm solar project for approval so that more people can enjoy solar savings on their utility bills.

Name	Address	Currently ha	ve Com.Sol/On a wait list
Alice Englebretsen	501 E. California, Urbana, IL	61801	Currently have Com. Sol.
Joyce Mast	607 S. Westlawn Ave., Cham	paign, 61821	Currently have Com. Sol.
Andrew Rehn	300 W Illinois St, Urbana IL 6	1801	On a wait list